ABBREVIATIONS LAM LES LLV LAMINATE(D)(ION) **ACCORDANCE** LEAD EXPANSION SHIELD ACOUSTIC ADJUSTABLE/ADJACENT ALTERNATE ALUMINUM MANUFACTURER ANCHOR BOLTS MASONRY OPENING MAXIMUM ARCH ASPH CONC ARCHITECT(URAL) ASPHALT CONCRETE PAVING **MECHANICAL** MECHANICAL CONTRACTOR MELAMINE COATED PARTICLE BOARD BEARING PLATE MOLDING, MOULDING MOUNTED BITUMINOUS BITUMINOUS DAMPPROOFING NATURAL NOT IN CONTRACT NOT TO SCALE NUMBER ON CENTER OFFICE OPEN PLAN OFFICE CEILING CENTER LINE CERAMIC TILE OPEN WEB STEEL JOISTS OPENING OUTSIDE DIAMETER CL CER T CIRC CJ CLO COMP CONC CONF CMU CONST CONT COORD DEM CERAMIC TILE CIRCULATION CONTROL JOINT CLOSET COLUMN COMPUTER CONCRETE CONFERENCE CONCRETE MASONRY UNITS OVERHEAD PARTITION PAINT(ED) PLUMBING CONTRACTOR PLYWOOD PRESSURE TREATED CONSTRUCTION POLYVINYL CHLORIDE CONTINUOUS RAIN WATER CONDUCTOR COORDINATE RECEPTION REINFORCING REINFORCING BARS REPRESENTATIVE REQUIRED RIGHT OF WAY ROOF ROOF DECKING DEMOLISH, DEMOLITION DIAMETER DIMENSION DOOR DOWN DOWNSPOUT DRINKING FOUNTAIN ELEVATION ROUGH OPENING SALVAGE & DELIVER TO OWNER SHEET SKYLIGHT SLATE SOLID CORE ELECTRIC(AL) ELECTRIC WATER COOLER ELECTRICAL CONTRACTOR LEVATION, ELEVATOR EXPANDED POLYSTERENE EQUAL EXISTING EXPANSION JOINT SPECIFICATION SPRINKLER STAINLESS STEEL STANDARD EXPOSED EXTERIOR EXTRUDED POLYSTYRENE FIBERGLASS BATT FIRE EXTINGUISHER CABINET FIRE RESISTANT TREATED WOOD FLASHING FLOOR TONGUE AND GROOVE FLOOR DRAIN TOP OF TOP OF CURB TOP OF FOOTER GALVÁNIZED TOP OF STEEL TOP OF WALL TYPICAL UNLESS NOTED OTHERWISE GENERAL CONTRACT(OR) GWB GWB-X HVAC HC GYPSUM DRYWALL (WALLBOARD) GWB, TYPE X (FIRE RESISTIVE CLASSIFICATION) VINYL COMPOSITION TILE HEATING, VENTILATING AND AIR CONDITIONING VERIFY IN FIELD VINYL WALL BASE HL-CMU HOLLOW LOADBEARING CMU VINYL WALL COVERING HOLLOW METAL STEEL HORIZONTAL WELDED WIRE FABRIC WITHOUT INSIDE DIAMETER WOLMANIZED INSULATE(D)(ION) WOOD NOTE: NOT ALL ABBREVIATIONS LISTED ARE APPLICABLE TO THIS PROJECT

<u>SECTIONS</u>

- SECTION NUMBER SHEET NUMBER

WINDOW TYPE

DOOR NUMBER

ROOM IDENTIFICATION

− ← ROOM NAME

REVIEW HARDWARE SCHEDULE, INTERIOR ELEVATIONS, & DETAILS, & PROVIDE FIRE TREATED SOLID WOOD BLOCKING INSIDE FIRE-RATED STUD WALLS & SOLID WOOD BLOCKING INSIDE STUD WALLS WHERE SOLID ANCHORAGE IS REQUIRED.

CONSTRUCTION &/OR NEW SCHEDULED FINISHES. REPAIRS SHALL MATCH EXISTING ADJACENT &/OR SIMILAR SURFACES & MATERIALS. TRANSITIONS

WHERE EXISTING CONSTRUCTION IS CUT & PATCHED, REPAIR ALL ADJACENT SURFACES DISTURBED BY CUTTING & PATCHING & PREPARE TO RECEIVE NEW

ALL FINISHED SURFACES IN THIS PROJECT ARE TO BE PATCHED & REPAIRED TO MATCH ADJACENT OR SIMILAR CONSTRUCTION & PREPARED TO RECEIVE

SPECIFIED FINISHES. THIS INCLUDES DAMAGED FLOORING. PLASTER, WOOD TRIM, CASINGS, SILLS & DOORS, WINDOW GLASS & MASONRY, TRANSITIONS

4. ALL MTL THAT COMES INTO CONTACT WITH PT WOOD SHALL BE STAINLESS OR GALV. STEEL. THIS INCLUDES BUT IS NOT LIMITED TO FASTNERS, FLASHING

6. SEAL AND FIRESTOP ALL PENETRATIONS AND OPENINGS IN ANY FIRE-RATED CONSTRUCTION USING PROPER FIRESTOPPING PRODUCTS INSTALLED IN

EMERGENCY LIGHTING SYSTEM: PROVIDE A MINIMUM OF ONE FOOT CANDLE OF ILLUMINATION FOR A MINIMUM DURATION OF ONE HOUR AS REQUIRED BY

8. MAKE CHANGES OR ADDITIONS TO THE EMERGENCY LIGHTING AND EXIT LIGHTING SYSTEMS AS REQUIRED BY THE CODE OFFICIAL. DURING THE JOB SITE

- - ROOM NUMBER

____ DETAIL NUMBER

SHEET NUMBER

ANNOTATION SYMBOLS

CONSTRUCTION NOTES

BETWEEN NEW & EXISTING CONSTRUCTION SHALL BE SMOOTH & UNNOTICEABLE.

BETWEEN NEW REPAIRS & EXISTING CONSTRUCTION SHALL BE SMOOTH & UNNOTICEABLE.

5. REPAIR ANY DAMAGE TO EXISTING OR NEW FIRE-RATED ENCLOSURES, CEILINGS AND WALLS.

INSPECTIONS THE CODE OFFICIAL MAY REQUIRE CHANGES OR ADDITIONS TO THE SYSTEMS.

ACCORDANCE WITH THE MANUFACTURER'S SPECIFICATIONS.

9. ALL MEANS OF EGRESS TO BE FREE & CLEAR AT ALL TIMES.

THE NATIONAL ELECTRICAL CODE AND IBC.

AND JOIST HANGERS. STRUCTURAL STL SHALL BE PRIMED AND PAINTED PRIOR TO CONTACT WITH PT WOOD.

OR CONTROL POINT

STAIR OR RAMP DIRECTIONAL ARROW

− ← ELEVATION NUMBER


DEMOLITION AND ALTERATIONS FOR

LYDIA HAMILTON SMITH HOUSE

LANCASTER, PA

HAMMEL ASSOCIATES ARCHITECTS, LLC Lancaster, PA

(717) 393.3713 FAX (717) 393.8227 WEB: WWW.HAMMELARCH.COM EMAIL: INFO@HAMMELARCH.COM

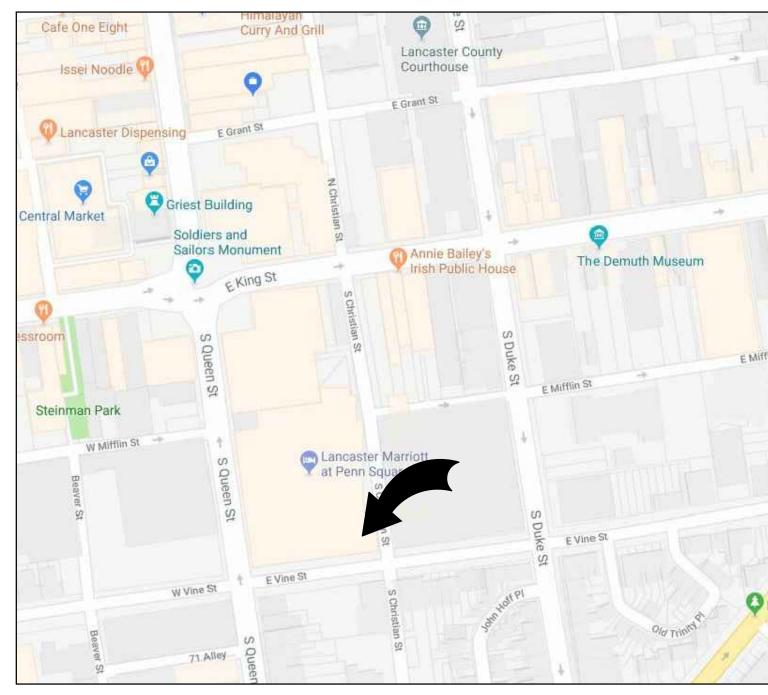







REVISIONS

R NOTIFICATION.

JOINT SEALER SCHEDULE

DRAWING DESIGNATION		DESCRIPTION OF JOINT CONSTRUCTION AND		
•	SEALANT TYPE	LOCATION WHERE JOINT SEALER IS TYPICALLY APPLIED. (SEE NOTE BELOW)		
ES-1	ONE-PART NONACID- CURING SILICONE SEALANT	EXTERIOR & INTERIOR VERTICAL JOINTS BETWEEN METAL & CONCRETE, UNIT MASONRY MORTAR, OR STONE; INTERIOR & EXTERIOR PERIMETER JOINTS OF METAL & WOOD FRAMES IN EXTERIOR WALLS; & EXTERIOR OVERHEAD JOINTS.		
ES-2	MULTI-PART POURABLE URETHANE SEALANT	EXTERIOR & INTERIOR JOINTS IN HORIZONTAL SURFACES OF CONCRETE; BETWEEN METAL & CONCRETE, MORTAR & MASONRY.		
ES-3	ONE-PART ACID-CURING SILICONE SEALANT	EXPOSED JOINTS WITHIN GLAZED CURTAIN WALL FRAMING SYSTEM, & ALUMINUM ENTRANCE FRAMING SYSTEM.		
ES-4	ONE-PART MILDEW- RESISTANT SILICONE SEALANT	RESTROOMS, LOCKER & SHOWER AREAS		
ES-5	TWO-PART URETHANE SEALANT	VERTICAL & HORIZONTAL JOINTS OF CONCRETE BETWEEN CONCRETE, POOL & CONCRETE DECK.		
LS	ACRYLIC-EMULSION SEALANT	INTERIOR JOINTS IN FIELD-PAINTED VERTICAL & OVERHEAD SURFACES AT PERIMETER OF HOLLOW METAL DOOR FRAMES; IN GYPSUM DRYWALL, PLASTER & CONCRETE OR CONCRETE MASONRY; & ALL OTHER INTERIOR JOINTS NOT INDICATED OTHERWISE.		
BAS-1	BUTYL-ASPHALT SEALANT, AC-20 IN ACCORDANCE WITH PA. DEPT. TRANSPORTATION TITLE 408 SPECIFICATIONS.	EXTERIOR JOINTS BETWEEN EXISTING & NEW ASPHALT PAVING & ASPHALT PAVING & MASONRY OR CONCRETE.		
FSS-1	FOAMED-IN-PLACE FIRE-STOPPING SEALANT	THROUGH PENETRATIONS IN FIRE RESISTANCE RATED FLOOR & WALL ASSEMBLIES INVOLVING MULTIPLE PIPES, CONDUITS & OTHER ITEMS.		

BUILDING DATA (2009 IBC)

OCCUPANCY:		USE GROUP B		
CONSTRUCTION T	YPE:	3B		
BUILDING HEIGHT	•	EXISTING		
FIRE ALARM SYST	EM:	YES		
EMERGENCY LIGHTING:		YES		
AUTOMATIC SPRIN	IKLERS:	YES		
AUTOMATIC FIRE DETECTION SYS	ТЕМ:	SMOKE DETECTORS		
_	.=== ==			
BUILDING AREA:				
BASEMENT	1336 SF			
FIRST FLOOR	1282 SF			
SECOND FLOOR	1582 SF			
THIRD FLOOR	1562 SF			
	5792 SF			

1. COMMONWEALTH OF PENNSYLVANIA, DEPARTMENT OF LABOR & INDUSTRY:

B. CITY OF LANCASTER BUILDING ORDINANCE AND ALL REFERENCED

EXISTING BUILDING CODE AND REFERENCED STANDARDS

AND ENERGY CODE WHERE APPLICABLE)

A. PENNSYLVANIA UNIFORM CONSTRUCTION CODE: 2009 INTERNATIONAL

REGULATIONS (BUILDING, EXISTING BUILDING, PLUMBING, ELECTRICAL,

MECHANICAL, FUEL GAS, PERFORMANCE, RESIDENTIAL, FIRE, ACCESSIBILITY

DRAWING INDEX

CS1.1 COVER SHEET ARCHITECTURAL DA1.1 DEMOLITION AND ALTERATION PLANS A1.1 FLOOR PLANS

A1.2 INTERIOR ELEVATIONS

STRUCTURAL FRAMING ALTERATION PLANS & GENERAL STRUCTURAL NOTES

HAMMEL ASSOCIATES ARCHITECTS, LLG

25 East Grant Street, Suite 102, Lancaster, PA 17602 Phone: 717 393-3713 Fax: 393-822

LANCASTER COUNTY **CONVENTION CENTER AUTHORITY**

PROJECT DESCRIPTION

LYDIA HAMILTON SMITH HOUSE PERMIT DRAWINGS EAST VINE STREET LANCASTER, PA

SHEET TITLE COVER SHEET


SCALE AS NOTED ISSUE DATE 2018,12,07 FILE NUMBER 1820 DRAWN BY ANE | CHECKED BY TLV


	SEALANT TYPE	TYPICALLY APPLIED. (SEE NOTE BELOW)
ES	-1 ONE-PART NONACID- CURING SILICONE SEALANT	EXTERIOR & INTERIOR VERTICAL JOINTS BETWEEN METAL & CONCRETE, UNIT MASONRY MORTAR, OR STONE; INTERIOR & EXTERIOR PERIMETER JOINTS OF METAL & WOOD FRAMES IN EXTERIOR WALLS; & EXTERIOR OVERHEAD JOINTS.
ES	-2 MULTI-PART POURABLE URETHANE SEALANT	EXTERIOR & INTERIOR JOINTS IN HORIZONTAL SURFACES OF CONCRETE; BETWEEN METAL & CONCRETE, MORTAR & MASONRY.
ES	-3 ONE-PART ACID-CURING SILICONE SEALANT	EXPOSED JOINTS WITHIN GLAZED CURTAIN WALL FRAMING SYSTEM, & ALUMINUM ENTRANCE FRAMING SYSTEM.
ES	-4 ONE-PART MILDEW- RESISTANT SILICONE SEALANT	RESTROOMS, LOCKER & SHOWER AREAS
ES	-5 TWO-PART URETHANE SEALANT	VERTICAL & HORIZONTAL JOINTS OF CONCRETE BETWEEN CONCRETE, POOL & CONCRETE DECK.
LS	ACRYLIC-EMULSION SEALANT	INTERIOR JOINTS IN FIELD-PAINTED VERTICAL & OVERHEAD SURFACES AT PERIMETER OF HOLLOW METAL DOOR FRAMES; IN GYPSUM DRYWALL, PLASTER & CONCRETE OR CONCRETE MASONRY; & ALL OTHER INTERIOR JOINTS NOT INDICATED OTHERWISE.
BA	S-1 BUTYL-ASPHALT SEALANT, AC-20 IN ACCORDANCE WITH PA. DEPT. TRANSPORTATION TITLE 408 SPECIFICATIONS.	EXTERIOR JOINTS BETWEEN EXISTING & NEW ASPHALT PAVING & ASPHALT PAVING & MASONRY OR CONCRETE.
FS	S-1 FOAMED-IN-PLACE FIRE-STOPPING SEALANT	THROUGH PENETRATIONS IN FIRE RESISTANCE RATED FLOOR & WALL ASSEMBLIES INVOLVING MULTIPLE PIPES, CONDUITS & OTHER ITEMS.
FS	S-2 ONE-PART FIRE-STOPPING SEALANT	THROUGH PENETRATIONS IN FIRE RESISTANCE RATED FLOOR & WALL ASSEMBLIES INVOLVING SINGLE PIPES, CONDUITS & WHERE JOINT WIDTHS ARE NARROW.


NOTE: INSTALL JOINT SEALANTS IN ACCORDANCE WITH DESCRIPTIONS AND LOCATIONS


LISTED, AND IN LOCATIONS IDENTIFIED ON DRAWINGS BY DRAWING

DESIGNATIONS LISTED ABOVE.

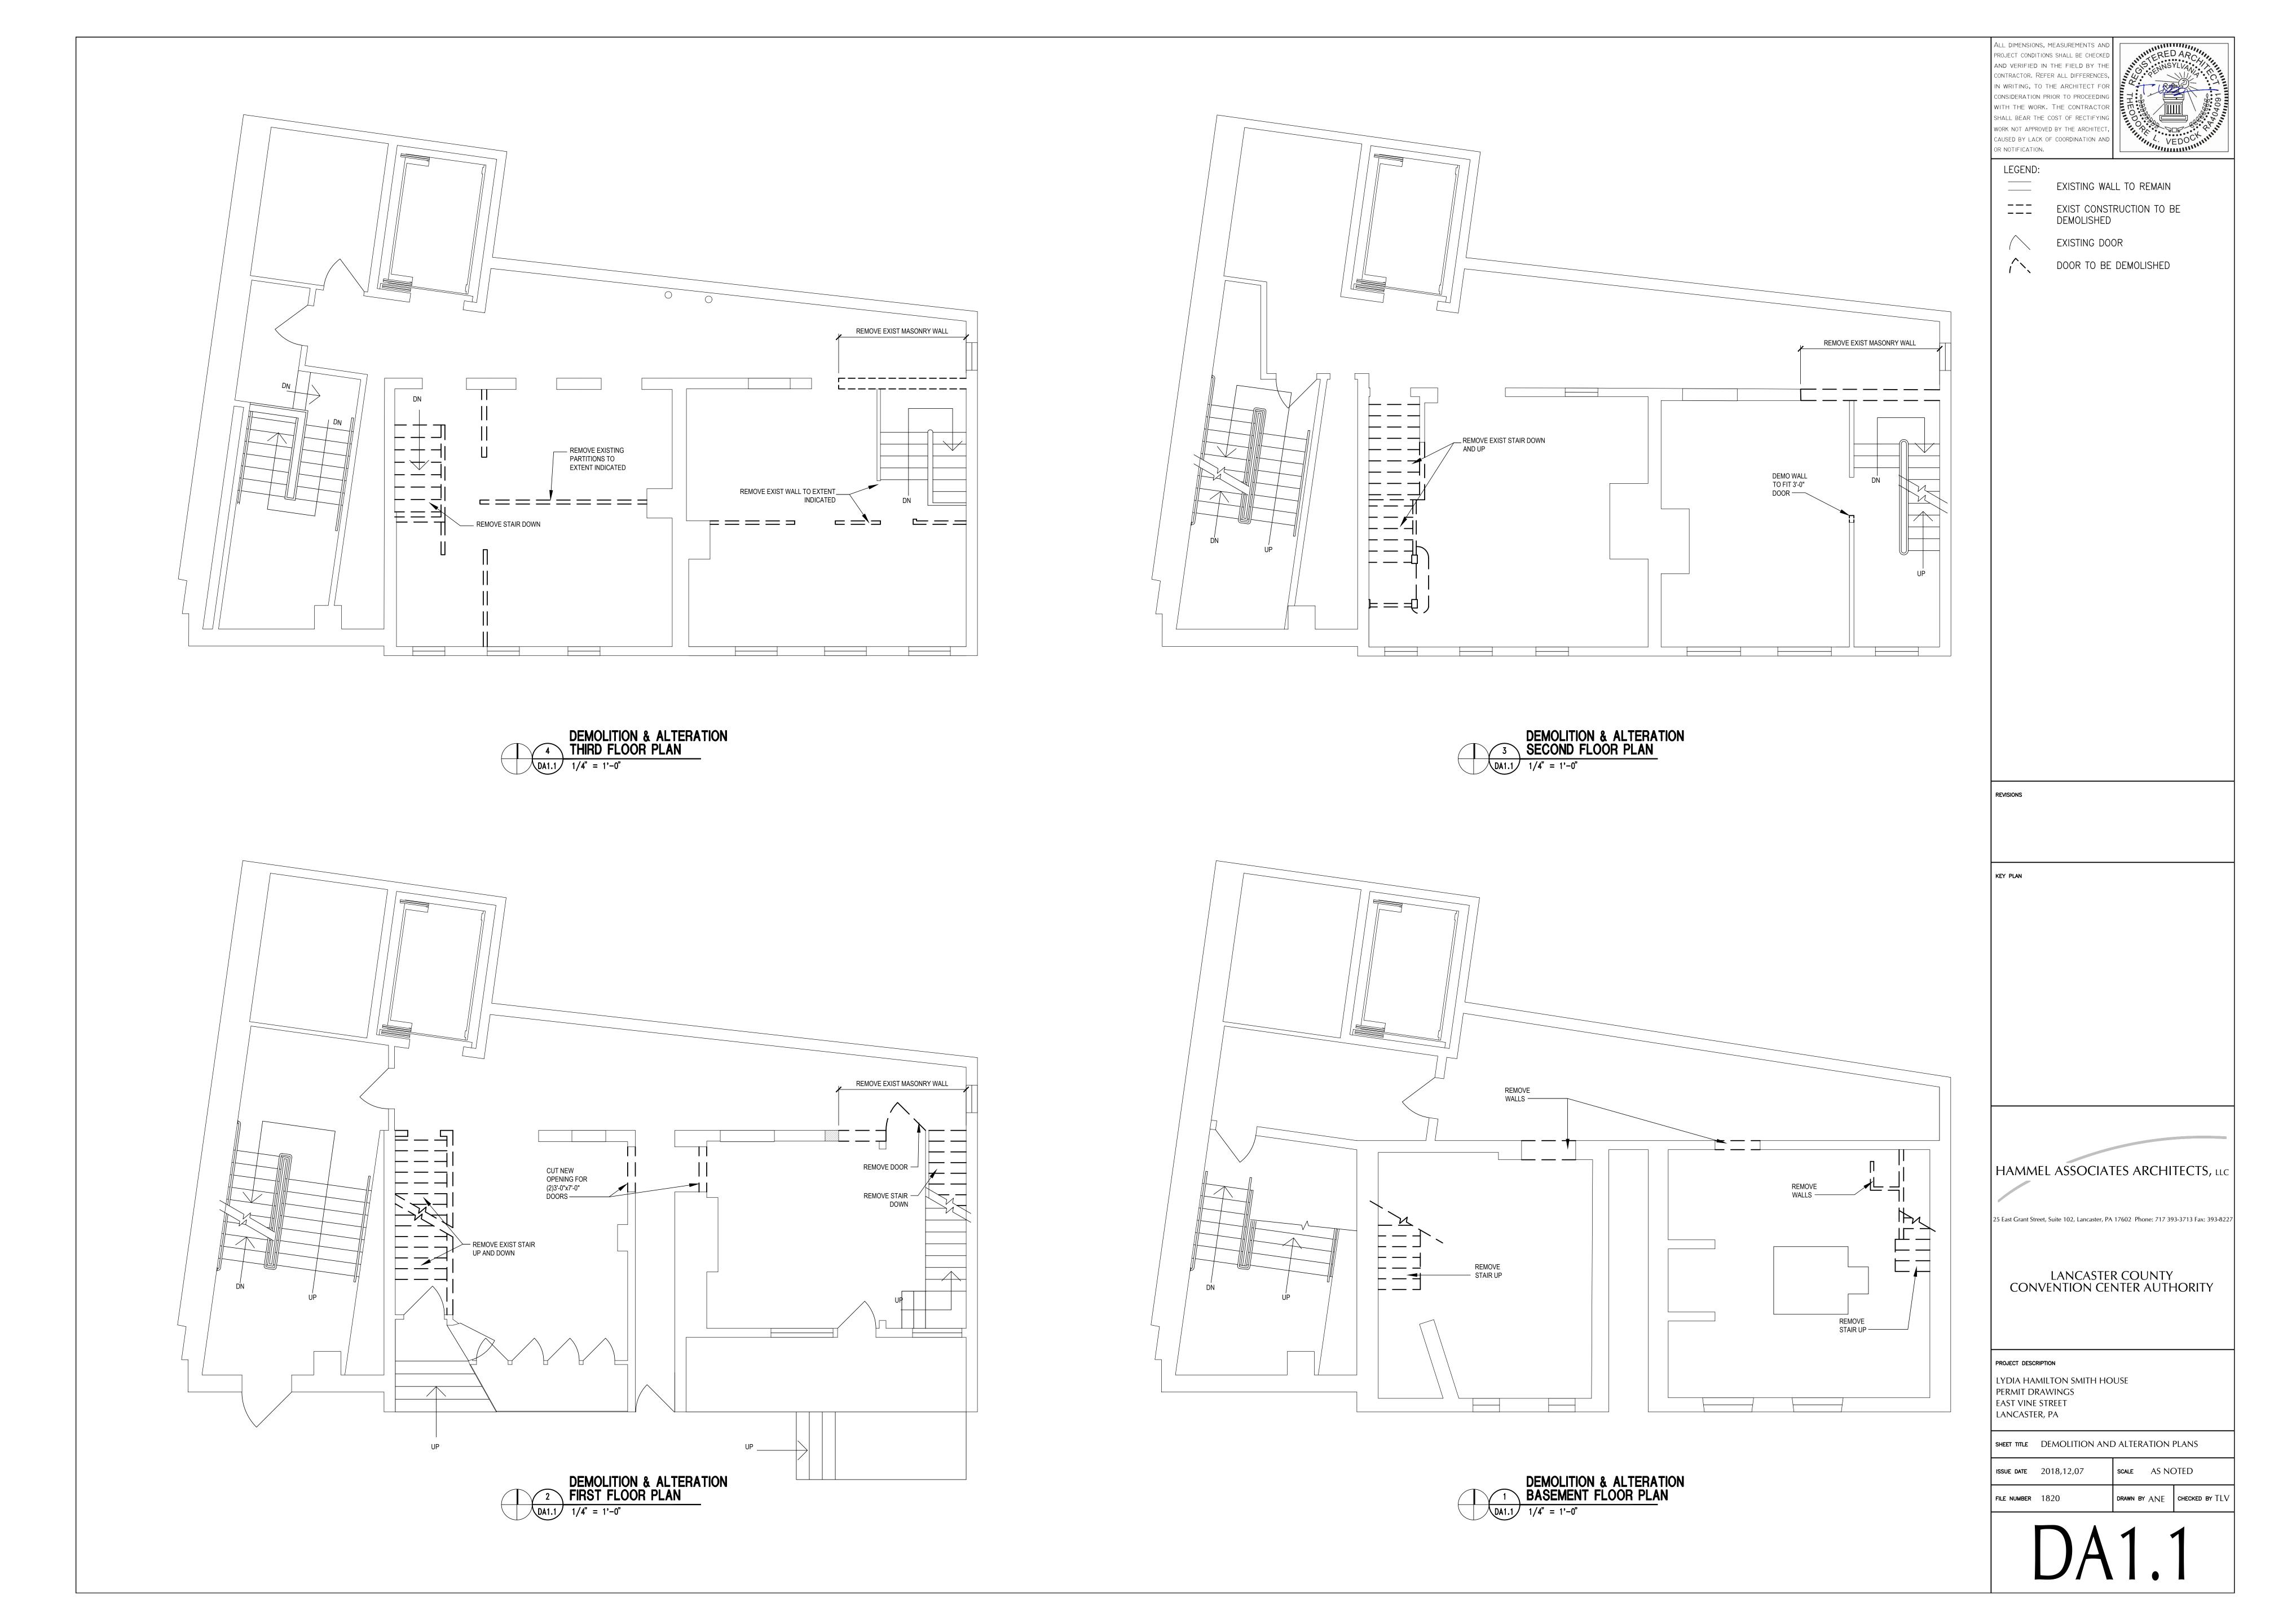

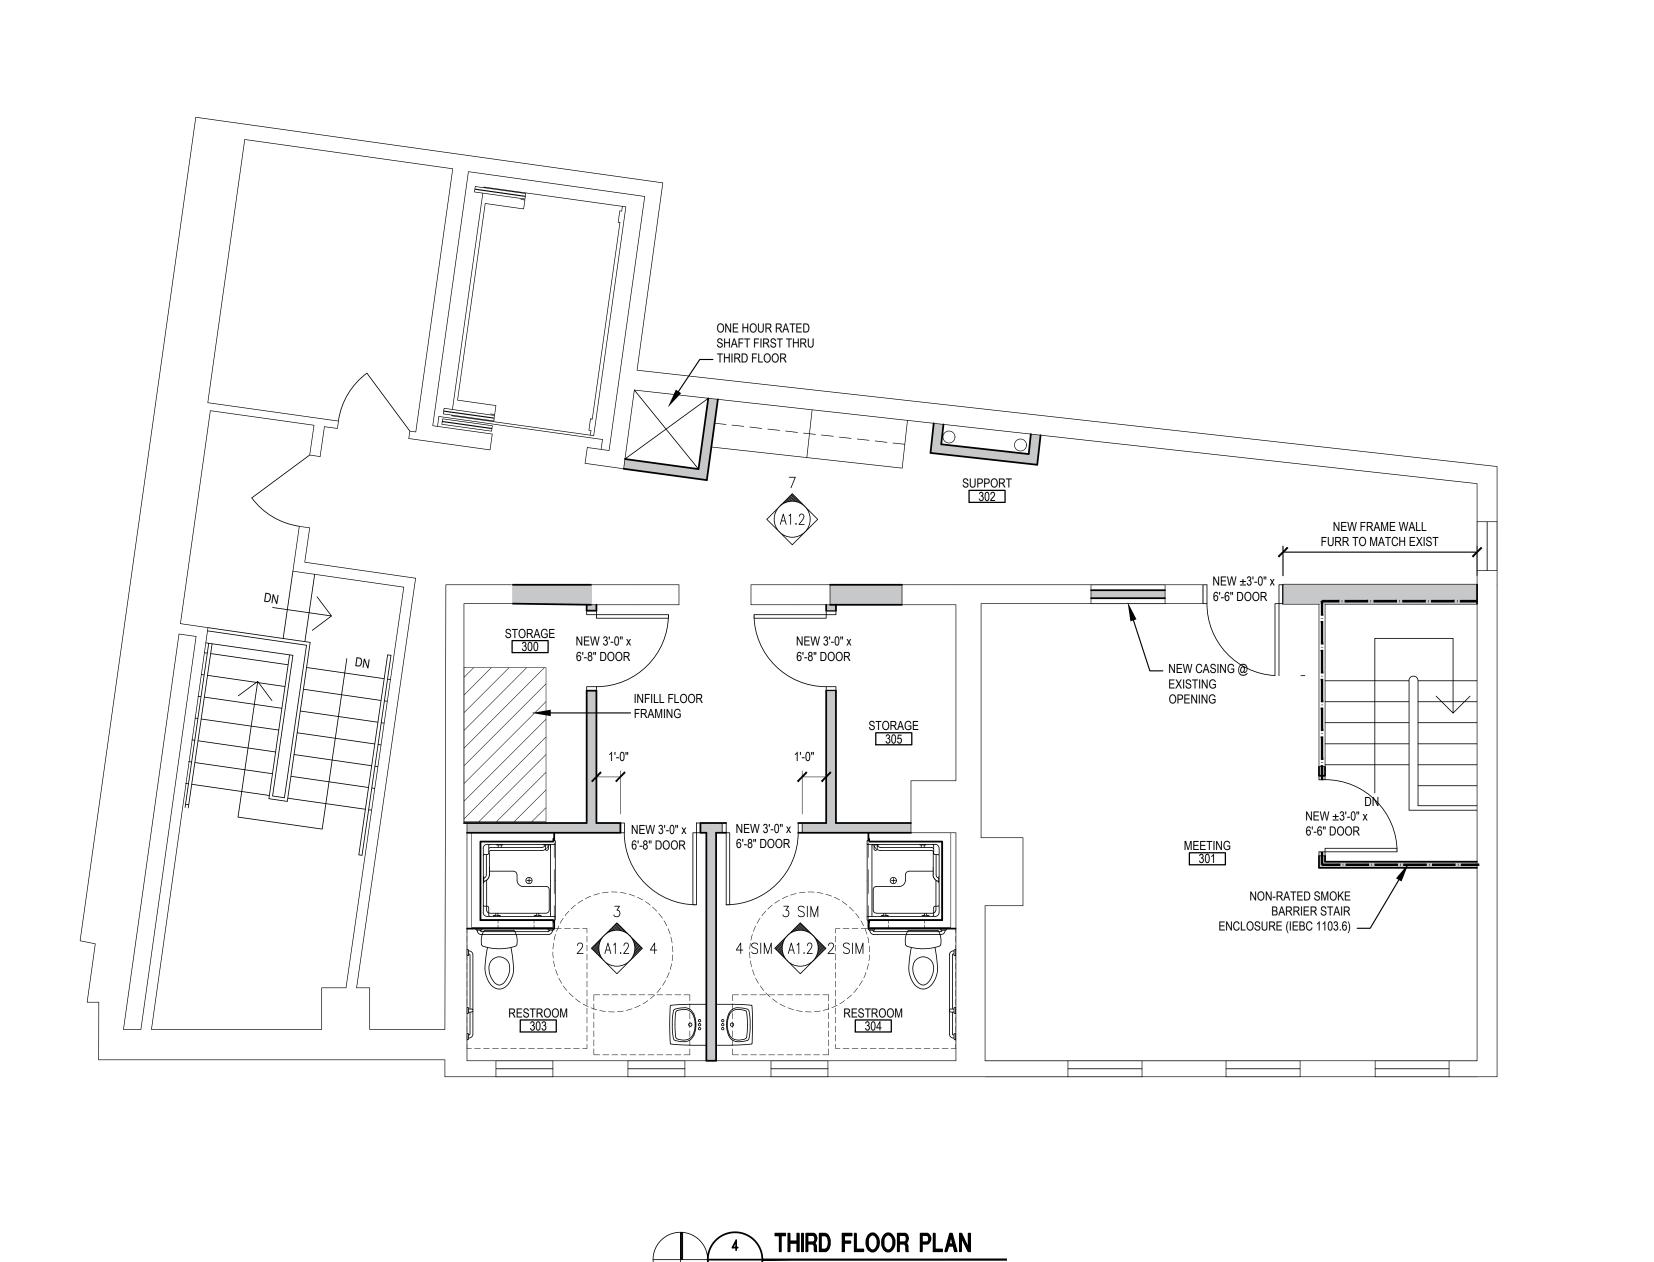

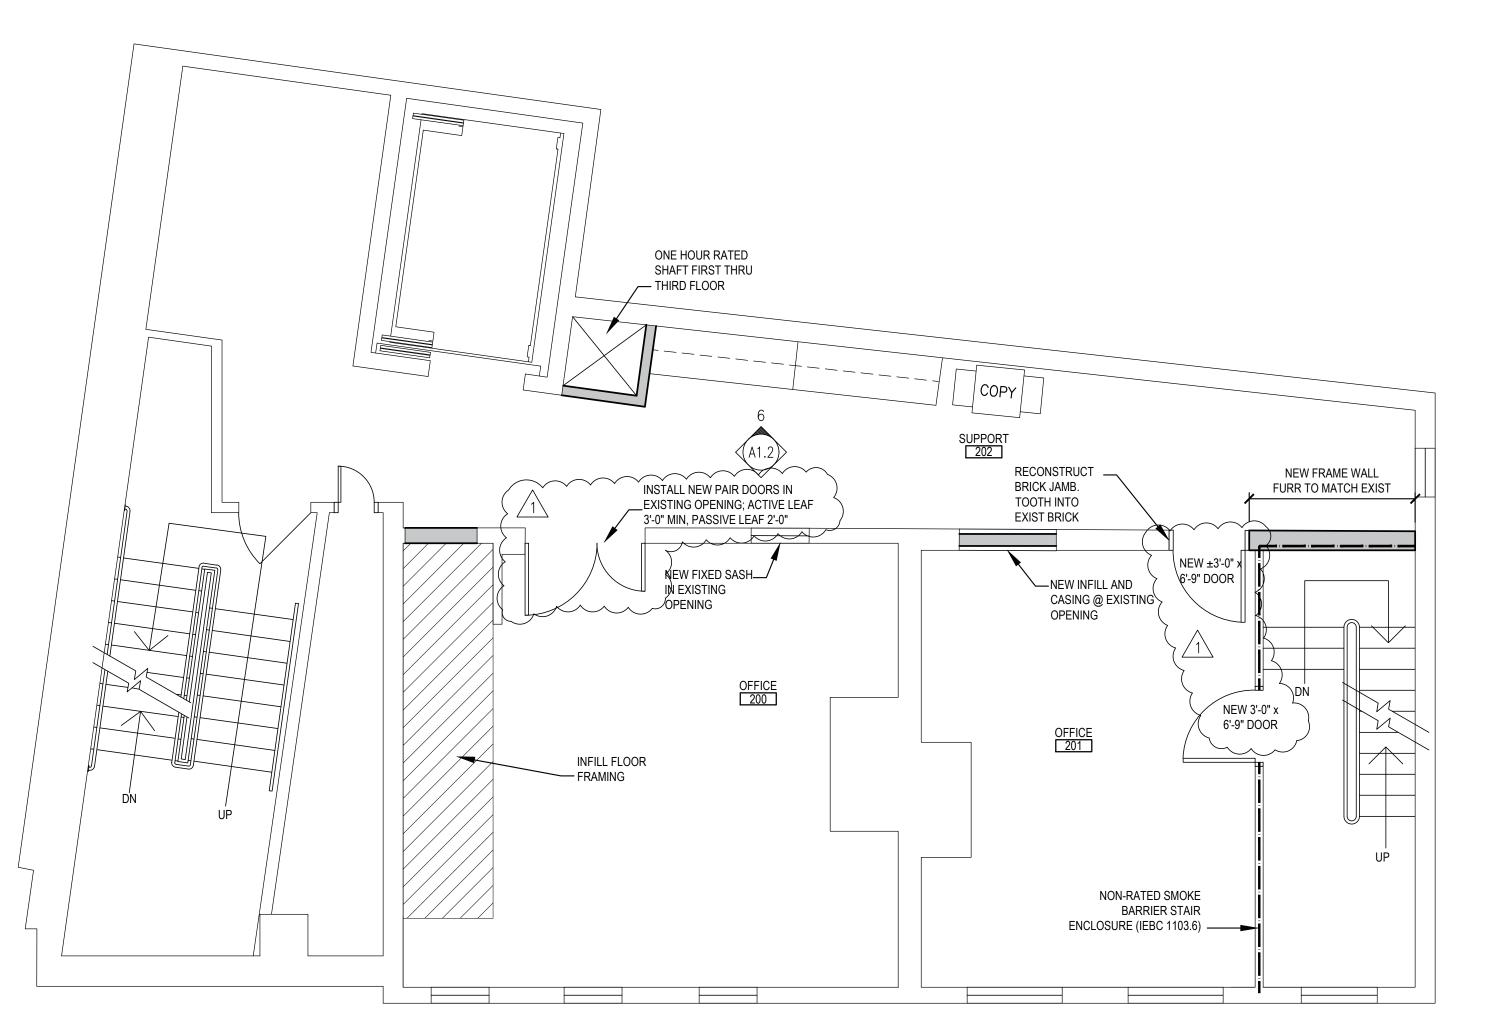

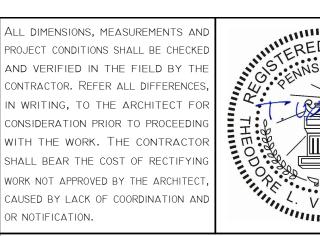

THEODORAL VEDOCK

LEGEND:

EXISTING WALL

NEW PARTITION WALL

NEW MASONRY INFILL

EXISTING DOOR

NEW DOOR

GENERAL NOTES:

1. INFILL FLOOR FRAMING TO BE 2x8 @16"
OC w/ ¾" APA PLYWOOD SUBFLOOR FOR OPENINGS UP TO 4'-0" CLEAR SPAN.

3 SECOND FLOOR PLAN
A1.1 1/4" = 1'-0"

WETT FOR PRIMARES
PRICE HER STATE TO
MAGINET HER STATE

1 BASEMENT FLOOR PLAN
A1.1 1/4" = 1'-0"

HAMMEL ASSOCIATES ARCHITECTS, LLC

25 East Grant Street, Suite 102, Lancaster, PA 17602 Phone: 717 393-3713 Fax: 393-8227

2019.02.07 PERMIT REVIEW COMMENTS

LANCASTER COUNTY CONVENTION CENTER AUTHORITY

PROJECT DESCRIPTION


LYDIA HAMILTON SMITH HOUSE
PERMIT DRAWINGS
EAST VINE STREET
LANCASTER, PA

SHEET TITLE FLOOR PLANS

ISSUE DATE 2018,12,07 SCALE AS NOTED

FILE NUMBER 1820 DRAWN BY ANE CHECKED BY TLV

A1.1

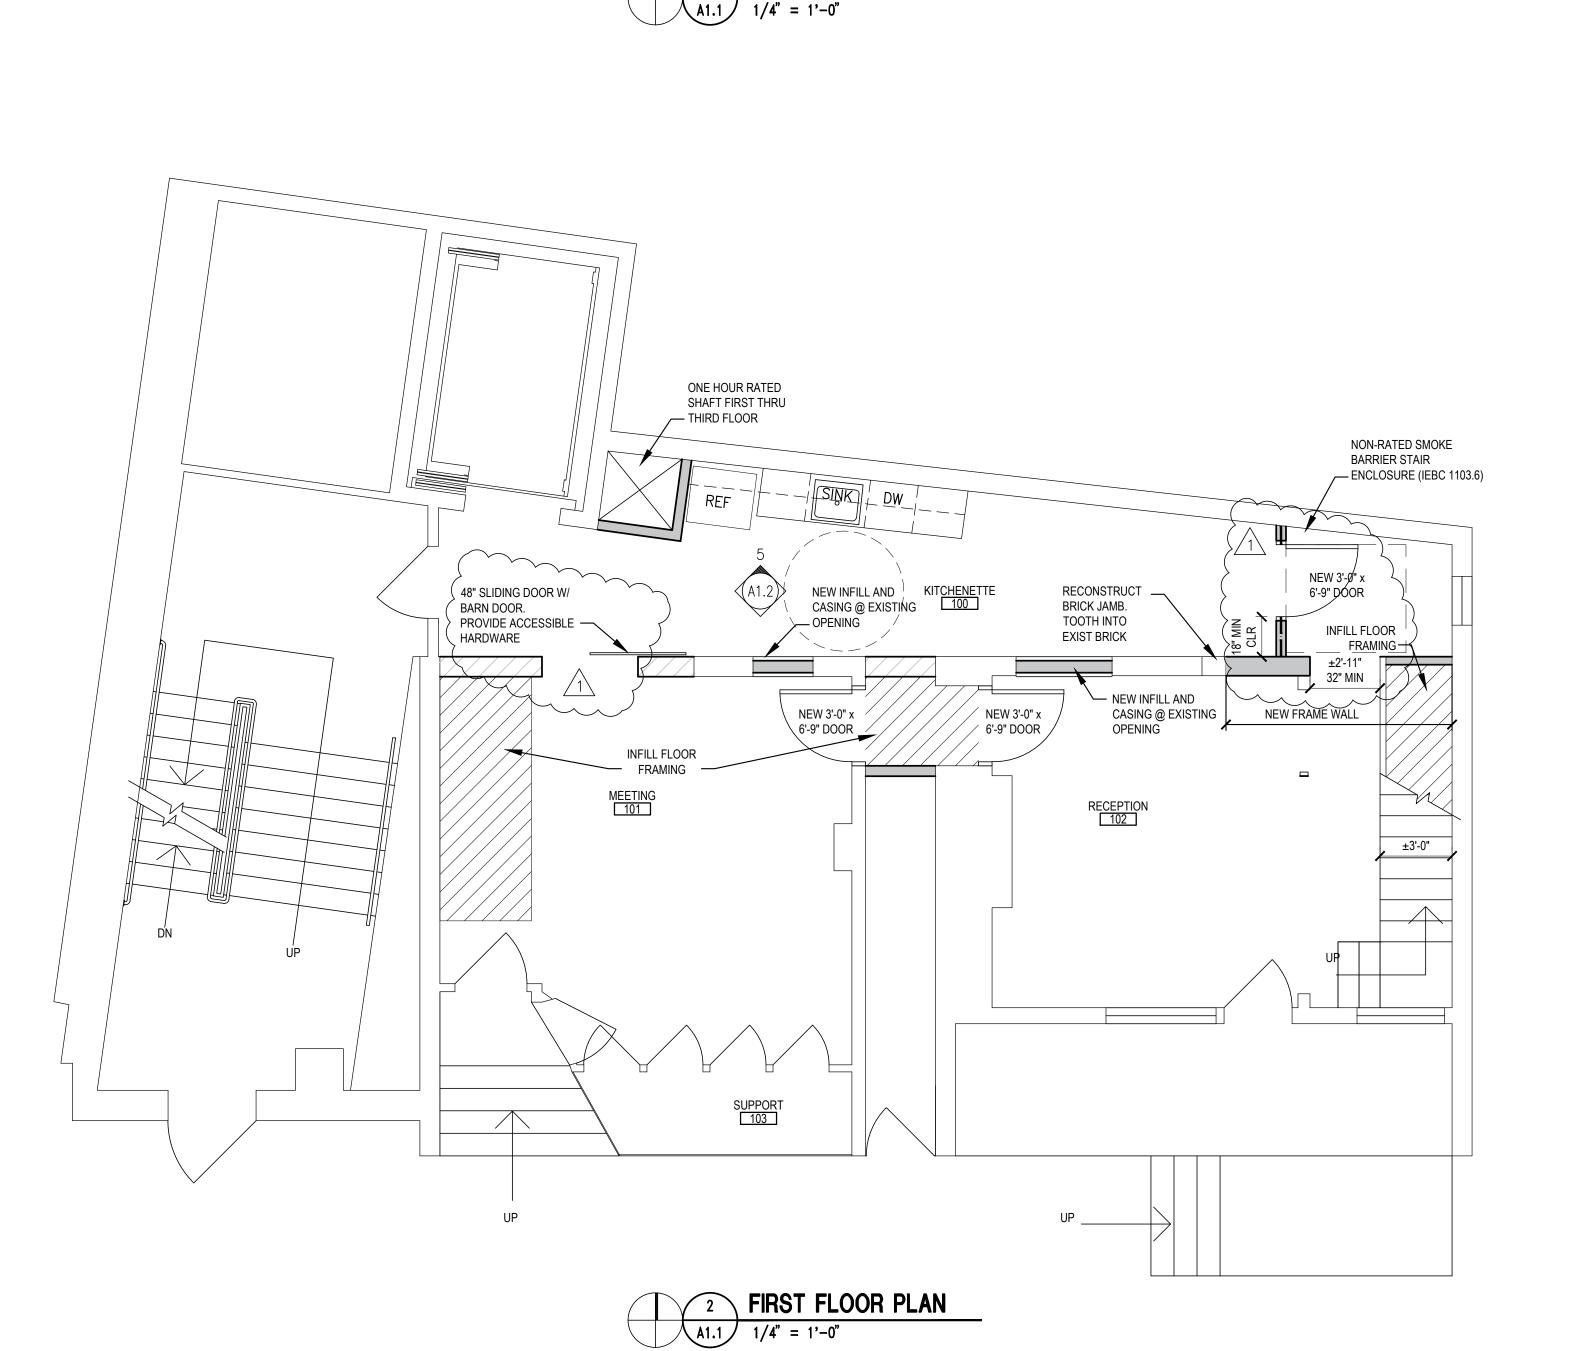


48" THIRD FLOOR SUPPORT ELEVATION

1/2" = 1'-0" SECOND FLOOR SUPPORT ELEVATION 1/2" = 1'-0" FIRST FLOOR KITCHENETTE ELEVATION A1.2 1/2" = 1'-0" TACTILE
ADA
RESTROOM
SIGN LANCASTER COUNTY CONVENTION CENTER AUTHORITY PROJECT DESCRIPTION LYDIA HAMILTON SMITH HOUSE PERMIT DRAWINGS EAST VINE STREET LANCASTER, PA SHEET TITLE INTERIOR ELEVATIONS RESTROOM EAST ELEVATION

1/2" = 1'-0" RESTROOM NORTH ELEVATION RESTROOM WEST ELEVATION ENLARGED RESTROOM PLAN 1/2" = 1'-0" A1.2 1/2" = 1'-0"

ALL DIMENSIONS, MEASUREMENTS AND PROJECT CONDITIONS SHALL BE CHECKED AND VERIFIED IN THE FIELD BY THE CONTRACTOR. REFER ALL DIFFERENCES, IN WRITING, TO THE ARCHITECT FOR ONSIDERATION PRIOR TO PROCEEDING WITH THE WORK. THE CONTRACTOR SHALL BEAR THE COST OF RECTIFYING WORK NOT APPROVED BY THE ARCHITEC CAUSED BY LACK OF COORDINATION AND OR NOTIFICATION.

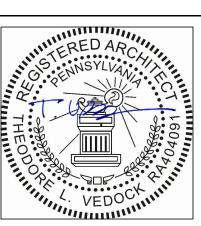

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